


BASEMENT PLAN (SCALE 1:50)

DOOR AND FRAME SCHEDULE			
MARK	Model	Rough Width	Rough Height
006	30x80	812.8	2095.5
006	30x80	812.8	2095.5
006	30x80	812.8	2095.5
006	30x80	812.8	2095.5

WINDOW SCHEDULE			
ROUGH OPENING (mm)			
MARK	Model	Rough Width	Rough Height
1	36x24	1219.2	609.6
1	36x24	1219.2	609.6
2	48x24	914.4	609.6

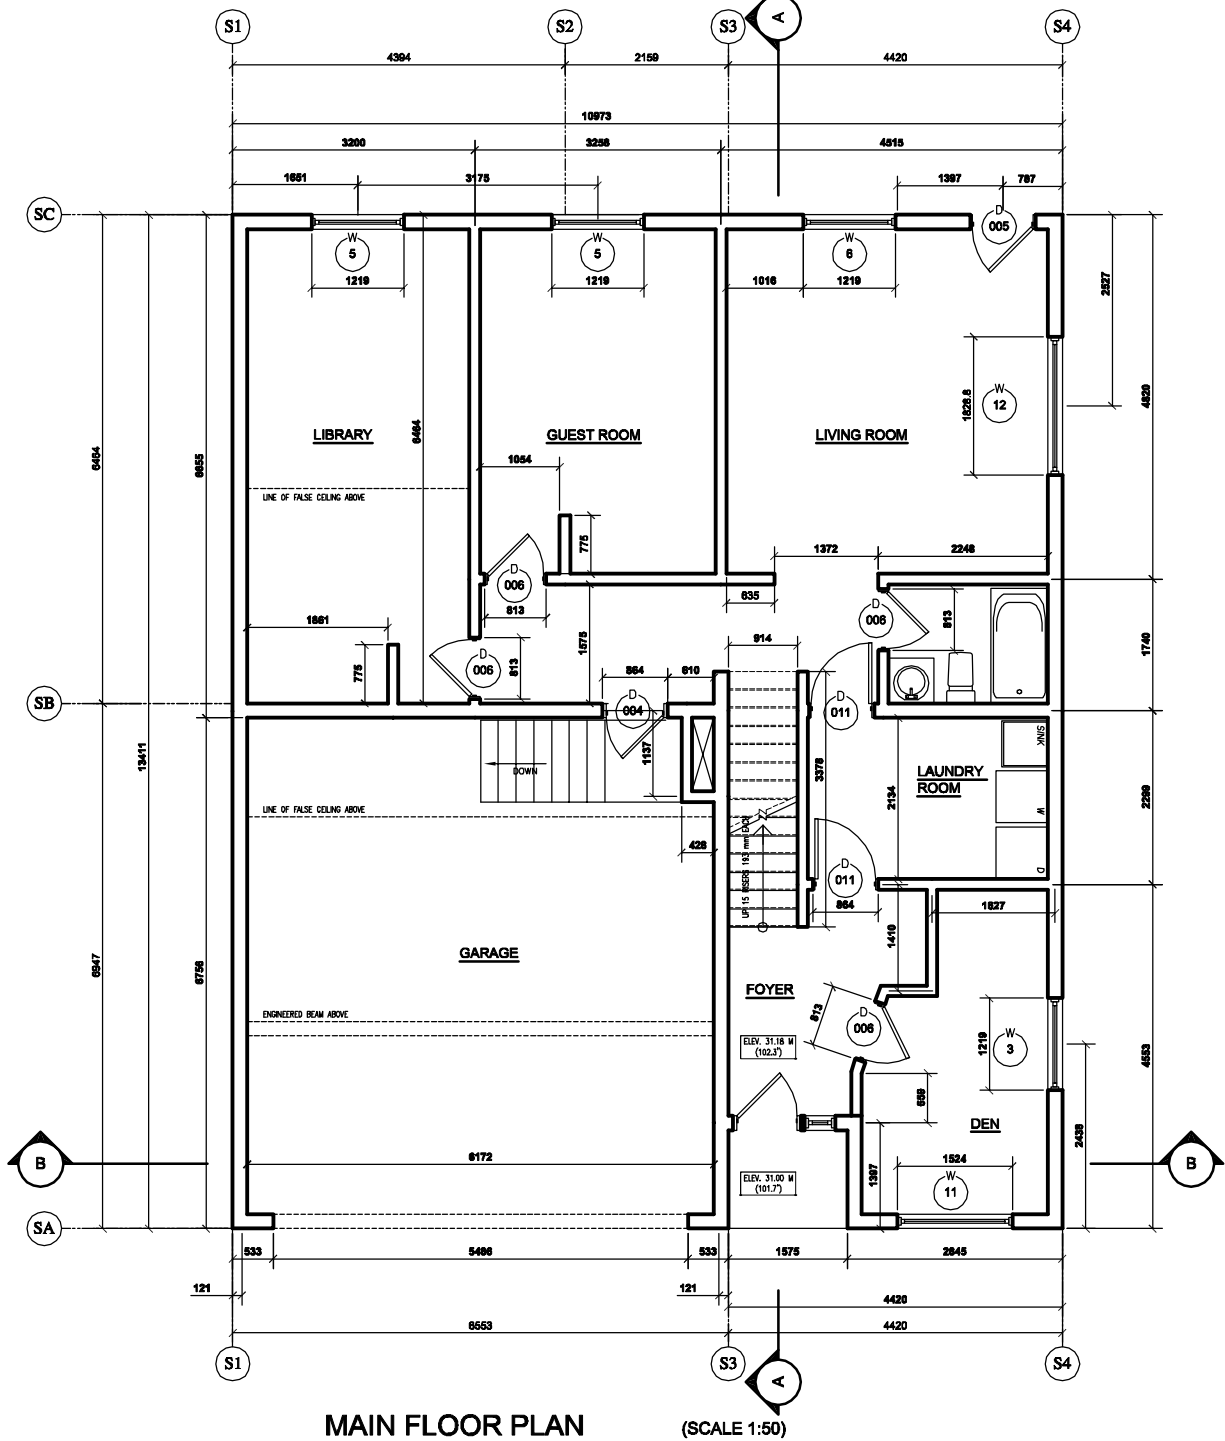

MAIN FLOOR PLAN (SCALE 1:50)

DOOR AND FRAME SCHEDULE			
MARK	Model	Rough Width	Rough Height
004	32x82E	863.6	2095.5
005	32x82E	863.6	2095.5
006	30x80	812.8	2095.5
006	30x80	812.8	2095.5
006	30x80	812.8	2095.5
006	30x80	812.8	2095.5
011	32x80	863.6	2095.5
011	32x80	863.6	2095.5

WINDOW SCHEDULE			
ROUGH OPENING (mm)			
MARK	Model	Rough Width	Rough Height
3	48x60	1219.2	1524
5	48x48	1219.2	1219.2
5	48x48	1219.2	1219.2
6	48x36	1219.2	914.4
11	60x80	1524	1524
12	72x60	1828.8	1524

NOTE A

ALL CONSTRUCTION OF WALLS (BEARING AND PARTITION) AND FLOORS WITH THE EXCEPTION OF THE BASEMENT AND GARAGE FOUNDATION WALLS FLOOR SLABS ARE PREFAB CONCRETE MANUFACTURED BY INTERNATIONAL HI-TECH PANELS ALL ENGINEERING AND SHOP DRAWINGS TO BE THE RESPONSIBILITY OF INTERNATIONAL HI-TECH

NOTE B

INSULATION/VE AND MEMBRANES ARE INTEGRAL TO THE PRE-FAB ROOF AND WALL PANELS

NOTES:

- ALL EXTERIOR WALLS IN BASEMENT ARE 203mm (8in) THICK AND CAST IN SITU CONCRETE. INTERIOR WALLS ARE AS NOTED.
- ALL WALL IN MAIN FLOOR ARE IHI PANELS. EXTERIOR WALLS ARE 190mm (7.5in) THICK AND INTERIOR WALLS ARE 140mm (5.5in) THICK UNLESS NOTED OTHERWISE.
- FOR DETAILS OF IHI PANELS REFER TO STRUCTURAL DRAWINGS.

No.	DATE	REVISION	BY
02	08/09/2002	AS PER CLIENT REQUEST & AND FOR CLIENT APPROVAL	
01	08/02/2002	AS PER CLIENT REQUEST & FOR CLIENT APPROVAL	

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MECHANICAL ENGINEERS:
ELECTRICAL ENGINEERS:
INTERIOR DESIGNERS:
LANDSCAPE ARCHITECTS:

DRAWING TITLE:
BASEMENT PLAN
&
MAIN FLOOR PLAN

DESIGN BY: LK	SCALE: 1/50
CHECKED BY:	DWG: JULY 2002
APPROVED BY: -- DIB	SHEET No: 1/1
FILE NAME: XXX	DWGING No: A02